

September 7, 2021

Mr. Garry Ford, P.E. City of New Braunfels 550 Landa Street New Braunfels TX 78130

RE: Waiver Request - Town Creek Phase 4
Section 118-43(b) – Request for Fredericksburg ROW Pavement Section Held Back from Property Line

Dear Garry,

Fredericksburg Right-of-Way located within Town Creek Phase 4 Plat is required by Section 118-43(b) to stub the pavement section to the adjacent property owned by a railroad. A section of the code is pasted below for reference. I am writing this letter to request the Fredericksburg pavement and sidewalks be held back from the Railroad property line. The Fredericksburg Right-of-Way would still be dedicated to the Railroad property line. Justification for this request is further explained in the following paragraphs.

"Wherever, the subject property adjoins undeveloped land, or wherever required by the city to serve the public good, utilities and drainage systems shall be extended to adjacent property lines to allow connection of these utilities and drainage systems by adjacent property owners when such adjacent property is platted and/or developed."

Should a railroad crossing be pursued in the future, we are left with three options:

- Overpass: This option would require removing almost the entire length of Fredericksburg pavement section back to N. Academy Ave to allow for bridge construction. This option would also remove proposed driveway aprons along Fredericksburg Ave.
- Underpass: This option would require removing the entire length of Fredericksburg pavement back to N. Academy for the underpass construction, causing the same conflict with proposed driveway aprons as option 1.
- 3. <u>At-Grade Crossing</u>: This option would require a railroad crossing agreement with Union-Pacific Railroad and could be pursued in the future as a viable option. However, to gain this road as an atgrade crossing, the removal of other more hazardous crossings in New Braunfels would be required. We believe this to be the best option available and are designing the proposed roadway to accept an at-grade crossing.


The exhibit attached in this application package depicts our proposed at-grade crossing design. If the pavement and sidewalk stub at property line, a dead-end would be stubbed 3.5 ft above surrounding grade. This would block opportunity of a smooth connection of a proposed walking path running along the northern perimeter of Block 5 in Phase 3 and Block 16 in Phase 4. In support of connecting the Town Creek subdivision with the Dry Comal Creek trail system and no current plans of connecting Fredericksburg at the railroad crossing, we believe stubbing the pavement to the property line does not serve the best interest of the public or Town Creek residents. It is our opinion holding this stub back from the property line will generate better pedestrian fluidity to the Town Creek Subdivision and avoid a dead-end condition 3.5 ft above surrounding grades. Additionally, we believe this dead-end street would come to be used as a parking area that could cause enforcement issues for the City.


We respectfully request an approval for the Fredericksburg pavement section to be held back as the attached exhibit shows. Please contact me if you have any questions or concerns.


Thank you,

Chris Van Heerde, PE Managing Partner

HMT Engineering & Surveying

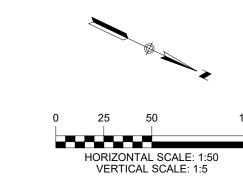

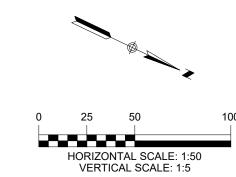

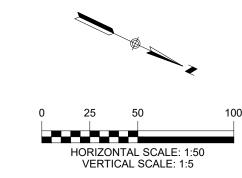

EXISTING CONTOURS PROPOSED CONTOURS BUILDING SETBACK LINE

UTILITY EASEMENT DRAINAGE EASEMENT

<u>LEGEND</u>

D.E.

A.D.A. RAMP (CITY OF NEW BRAUNFELS DETAIL ST 019)

FLOW ARROW

SPILL CURB

PROPOSED GROUND CENTER (PR TC) ACCESSIBLE CROSSING AREA CONTRACTOR TO ENSURE MAX 2% CROSS SLOPE IN THESE AREAS

SIDEWALK TO BE CONSTRUCTED BY SITE DEVELOPMENT CONTRACTOR



WASHOUT

<u>NOTES</u>

- STREETS WERE DESIGNED TO POSTED SPEED LIMIT OF 25 MPH.
- IN WASHOUT CROWN AREAS, THE CURB ON THE HIGH SIDE OF THE STREET SHOULD BE SPILL CURB AS DESIGNATED ON THE PLANS.
- 3. CONTRACTOR TO CONSTRUCT SIDEWALK RAMPS WITH STREETS.
- 4. CONTRACTOR TO ENSURE POSITIVE DRAINAGE AWAY FROM STREET STUB OUT ENDS SO THAT NO "PONDING" OF WATER OCCURS.


THE LOCATION OF ALL EXISTING UNDERGROUND UTILITIES ARE

SHALL DETERMINE THE EXACT LOCATION OF ALL EXISTING

DAMAGES WHICH MIGHT BE INCURRED BY THEIR FAILURE TO EXACTLY LOCATE AND PRESERVE ANY AND ALL UNDERGROUND UTILITIES, STRUCTURES OR FACILITIES.

CONTRACTOR SHALL NOTIFY ENGINEER OF ANY DISCREPANCIES 24-HOURS PRIOR TO COMMENCING CONSTRUCTION.

UTILITIES BEFORE COMMENCING WORK. THE CONTRACTOR WILL AGREE TO BE FULLY RESPONSIBLE FOR ANY AND ALL

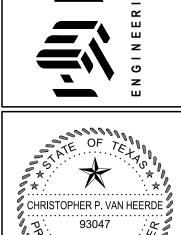


STE. 100 78130

6/30/2021

K SUBDIVISION ASE 4

FREDERICKSBURG RD PLAN AND PROFILE

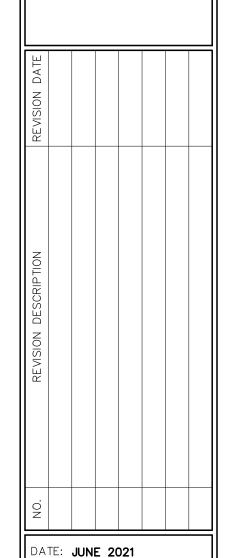



DRAWN BY: LB DESIGNED BY: HC SHOWN IN APPROXIMATE LOCATIONS ONLY. THE CONTRACTOR


EVIEWED BY: SWH/CVH HMT PROJECT NO .:

130.014 SHEET


C5.5

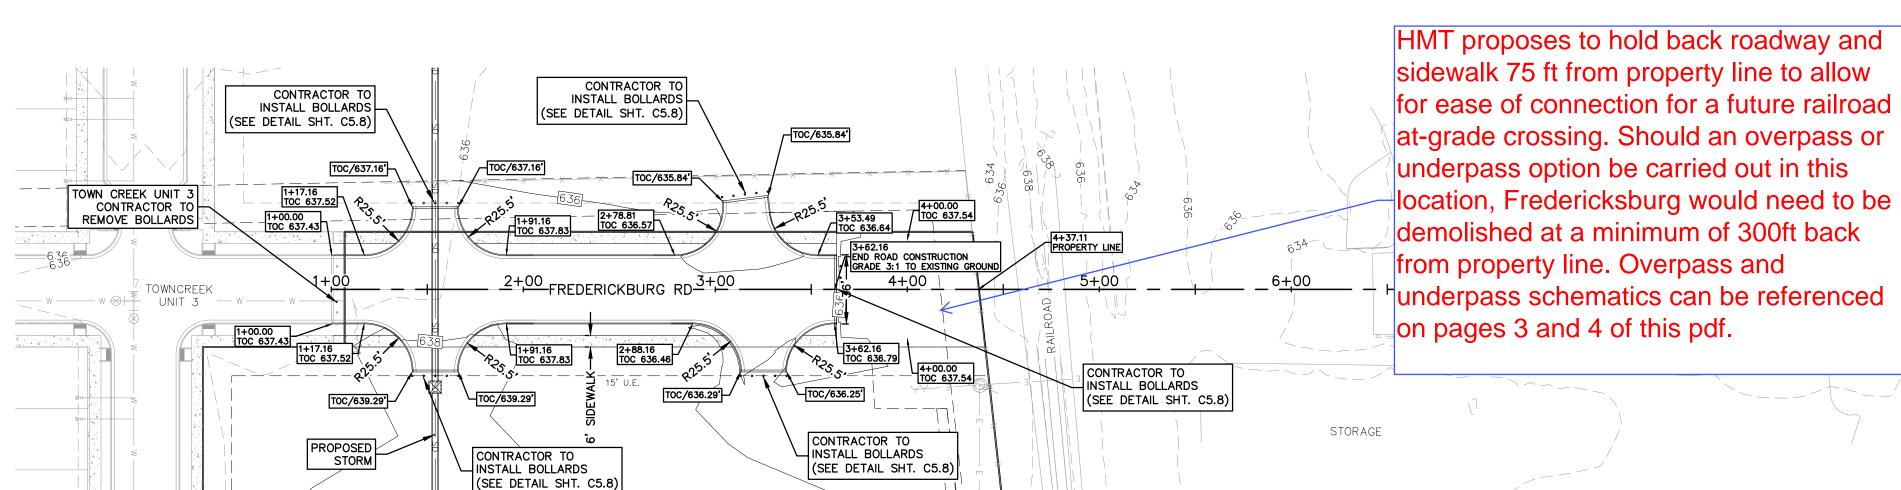

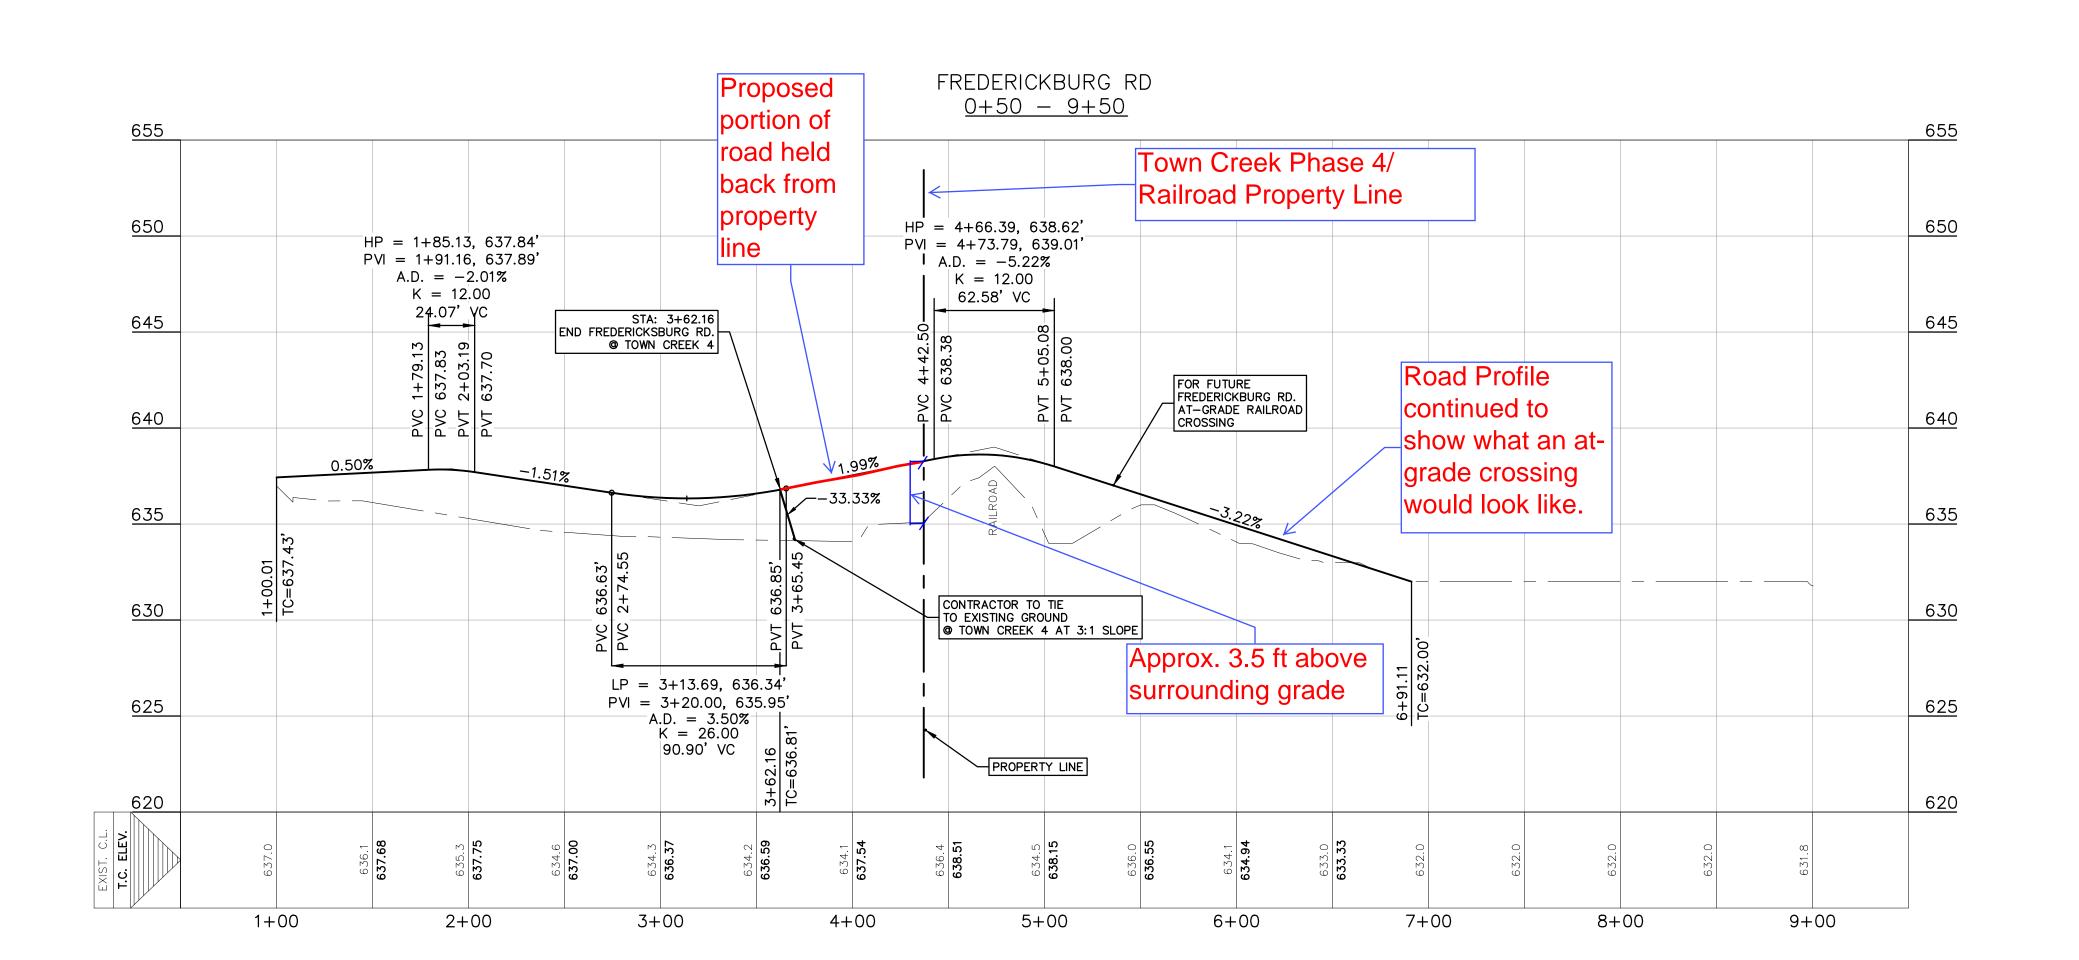

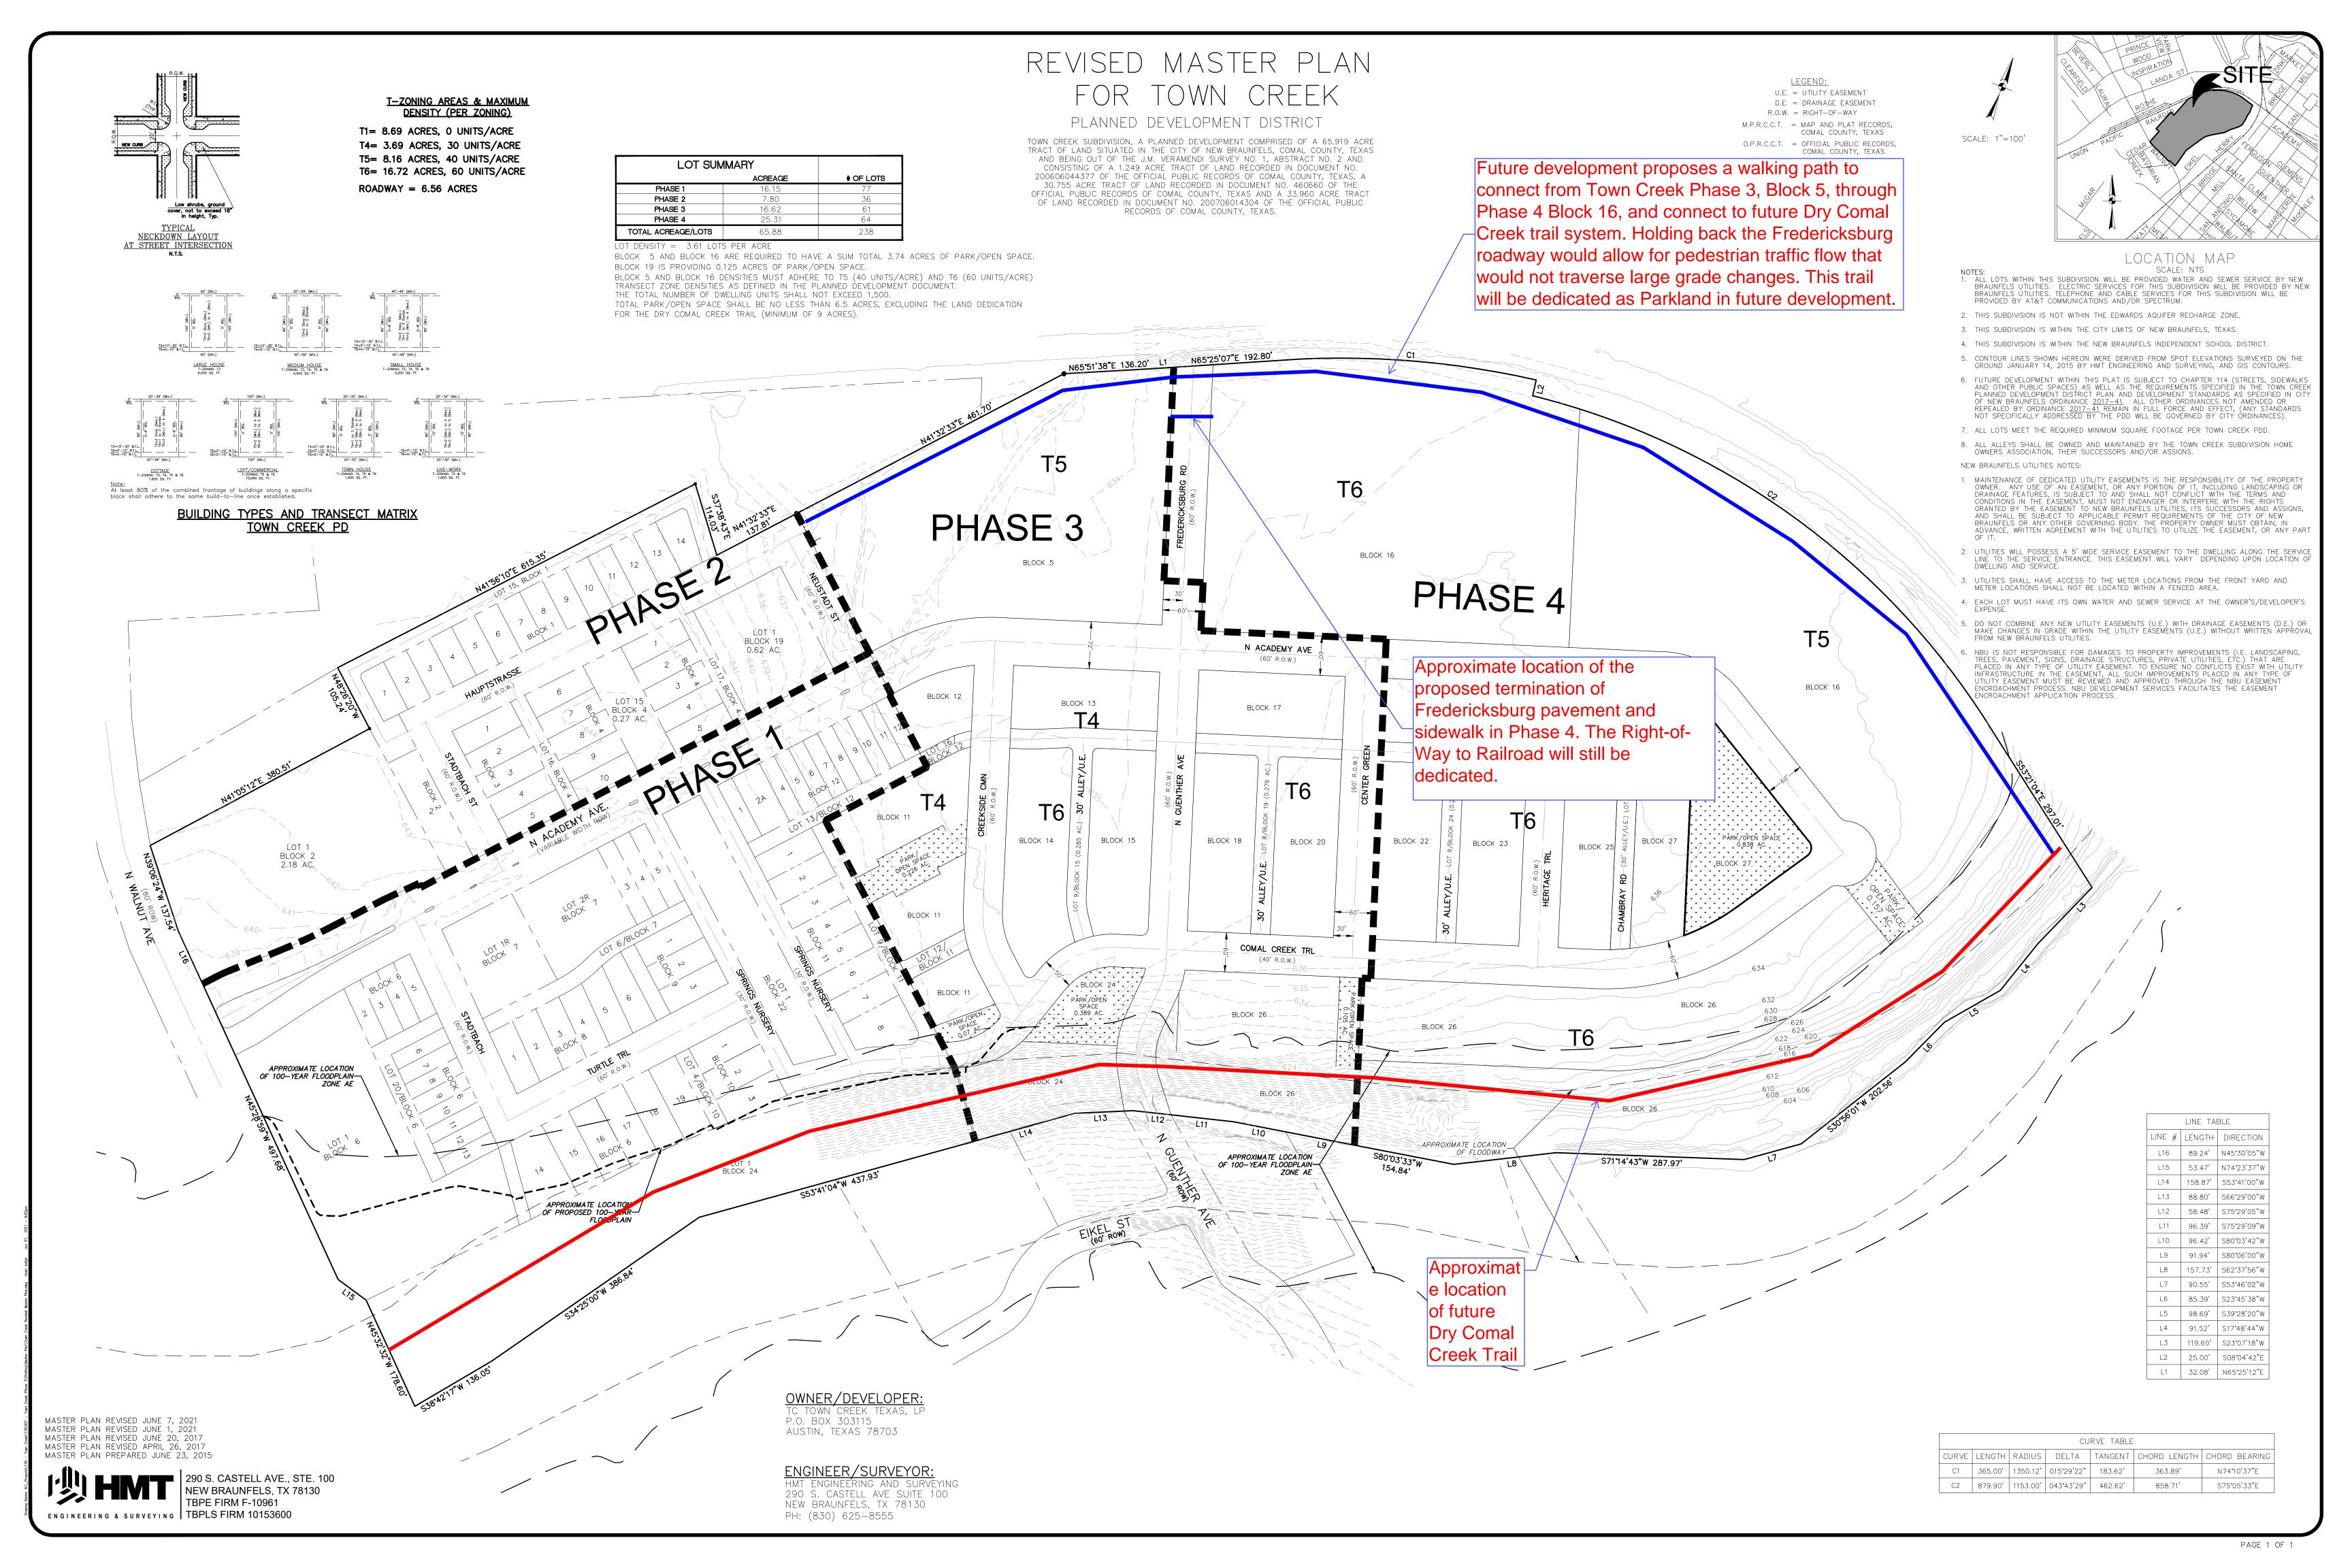




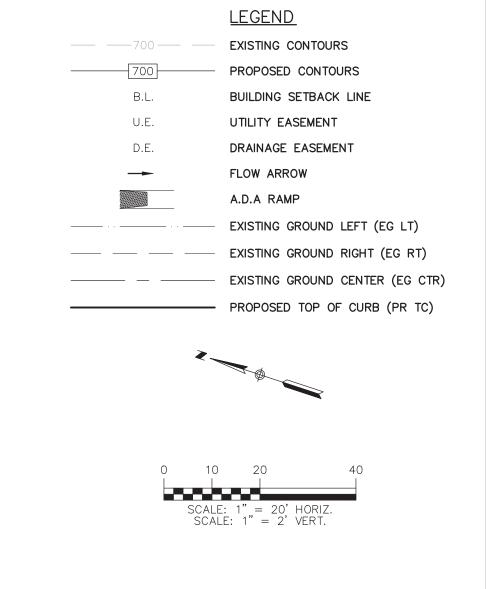

DESIGN SPEED = 25 MPH

KSBURG EXHIBIT FREDRICE BRIDGE

Bridge Exhibits are included as a visual reference for Options 1 and 2 described in the letter of explanation. The roadway shown is an outdated version of Fredericksburg and N. Academy intersection.

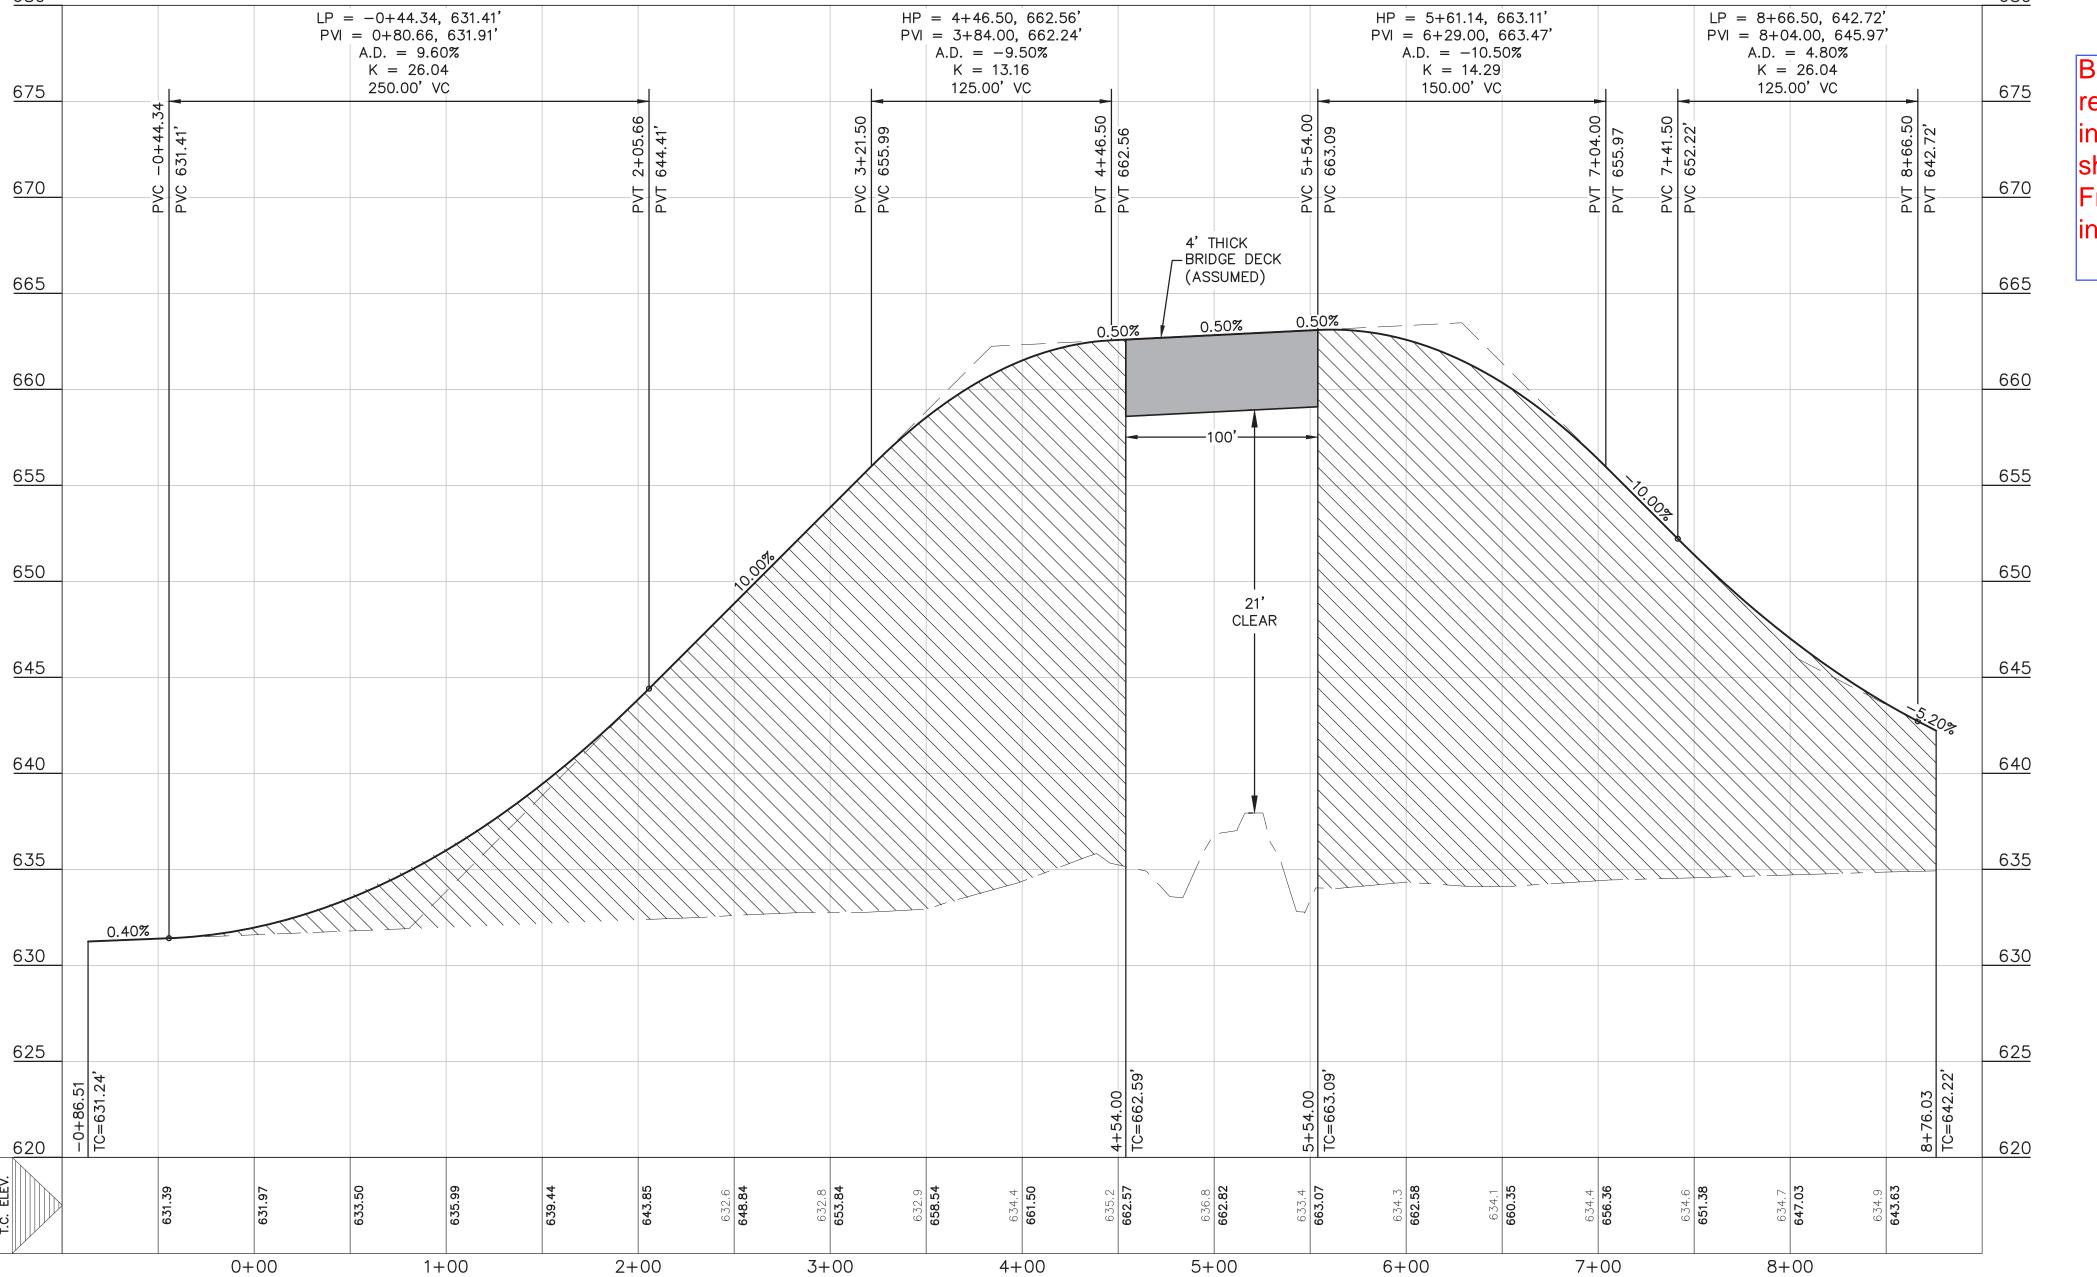

FREDERICKSBURG AVE

THE LOCATION OF ALL EXISTING UNDERGROUND UTILITIES ARE DAMAGES WHICH MIGHT BE INCURRED BY THEIR FAILURE TO EXACTLY LOCATE AND PRESERVE ANY AND ALL UNDERGROUND UTILITIES, STRUCTURES OR FACILITIES. CONTRACTOR SHALL NOTIFY ENGINEER OF ANY DISCREPANCIES

24-HOURS PRIOR TO COMMENCING CONSTRUCTION.

SHEET **of** 20

TOWNCREEK-PHASE 3A IMPROVEMENTS CIVIL SITE CONSTRCUTION PLANS

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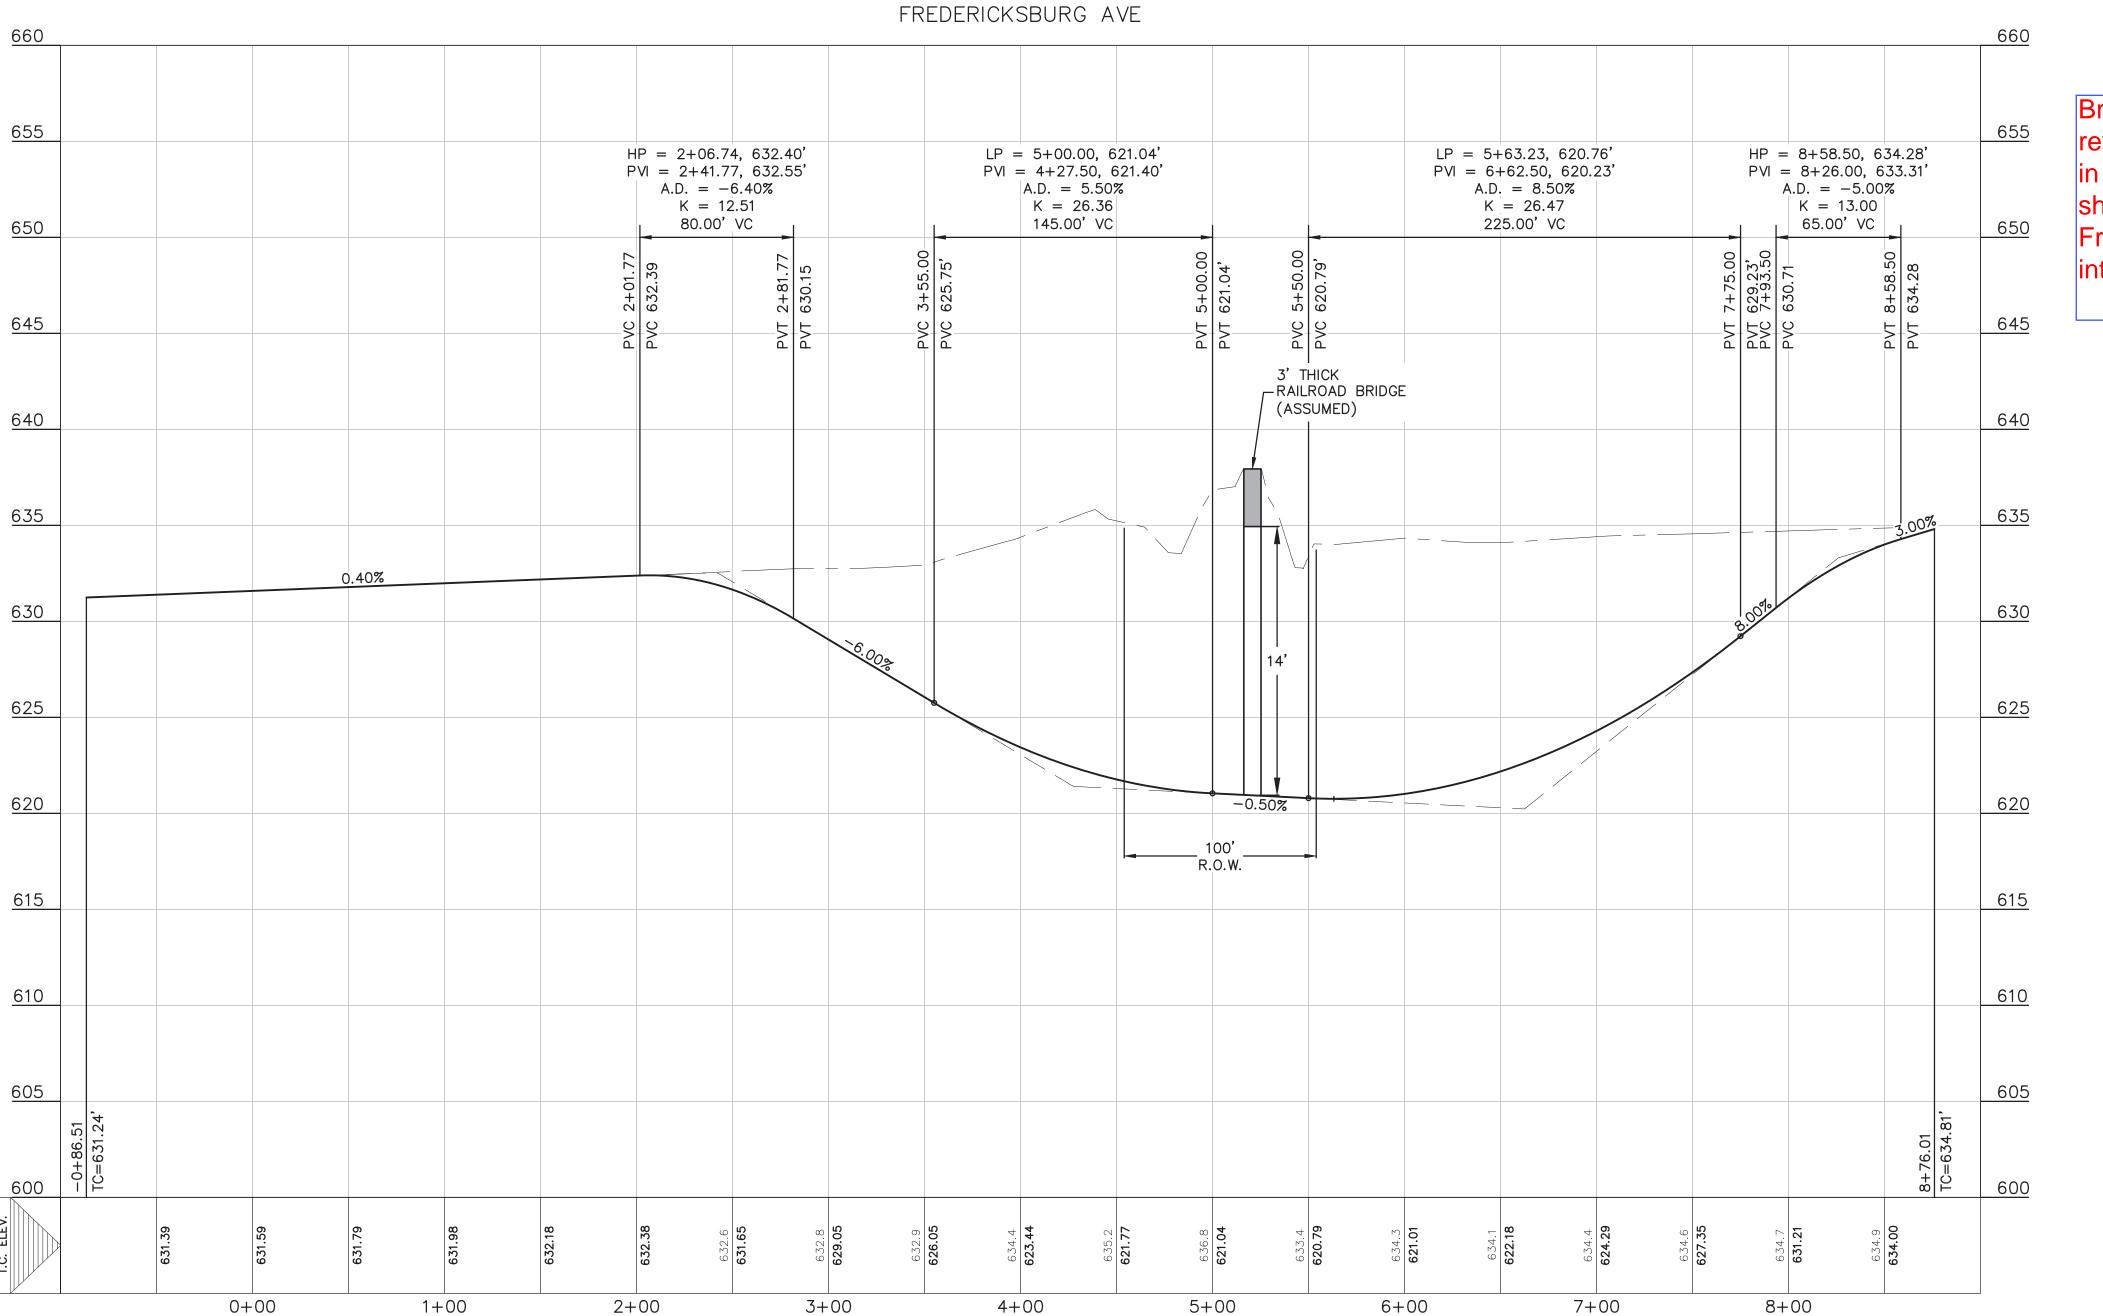


<u>LEGEND</u> EXISTING CONTOURS PROPOSED CONTOURS BUILDING SETBACK LINE UTILITY EASEMENT DRAINAGE EASEMENT FLOW ARROW A.D.A RAMP EXISTING GROUND LEFT (EG LT) EXISTING GROUND RIGHT (EG RT) EXISTING GROUND CENTER (EG CTR) PROPOSED TOP OF CURB (PR TC) SCALE: 1" = 20' HORIZ.SCALE: 1" = 2' VERT.

DESIGN SPEED = 25 MPH

FREDERICKSBURG NDERPASS EXHIBI

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